

SECTIONS 13 & 24, TOWNSHIP 35 NORTH, RANGE 10 EAST, WILLAMETTE MERIDIAN, WHATCOM COUNTY, WASHINGTON

GRADING PLANS


MARBLEMOUNT QUARRY

PROJECT ADDRESS: ROCKPORT CASCADE ROAD, NEAR MARBLEMOUNT, SKAGIT COUNTY, WA

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SHEET NUMBER	SHEET TITLE
01	COVER
02	EXISTING CONDITIONS
03	OVERALL SITE PLAN
04	TEMPORARY EROSION AND SEDIMENTATION CONTROL PLAN
05	SHEET MAP
06	SITE IMPROVEMENTS NORTH
07	SITE IMPROVEMENTS SOUTH
08	. SITE IMPROVEMENTS EAST
09	ROADWAY PLAN 20+00 TO 30+00
10	ROADWAY PLAN 30+00 TO 40+00
11	ROADWAY PLAN 40+00 TO 50+70
12	ROADWAY PLAN 50+70 TO 61+30
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16	WATERCOURSE CROSSING SECTION C-C
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20	SWPPP NOTES
21	ROAD DETAILS
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24	STORM DETAILS 2

ABBREVIATIONS KEY

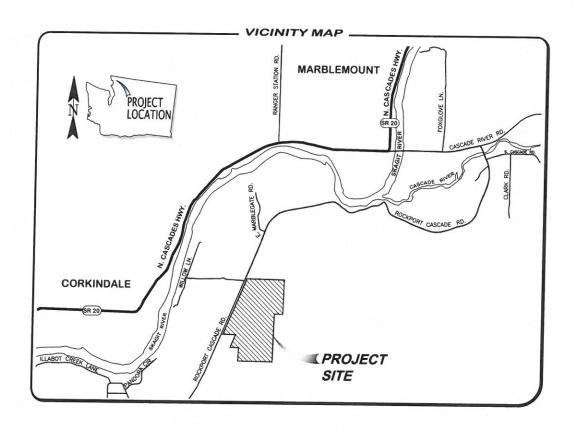


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BUILT:	DESIGN	PD	DG	VERT:					2	PRE-APP SUBMITTAL	NOV. 21, 2018	
BOILT:	XREF:								3	GRADING PERMIT SUBMITTAL	JAN. 15, 2019	1
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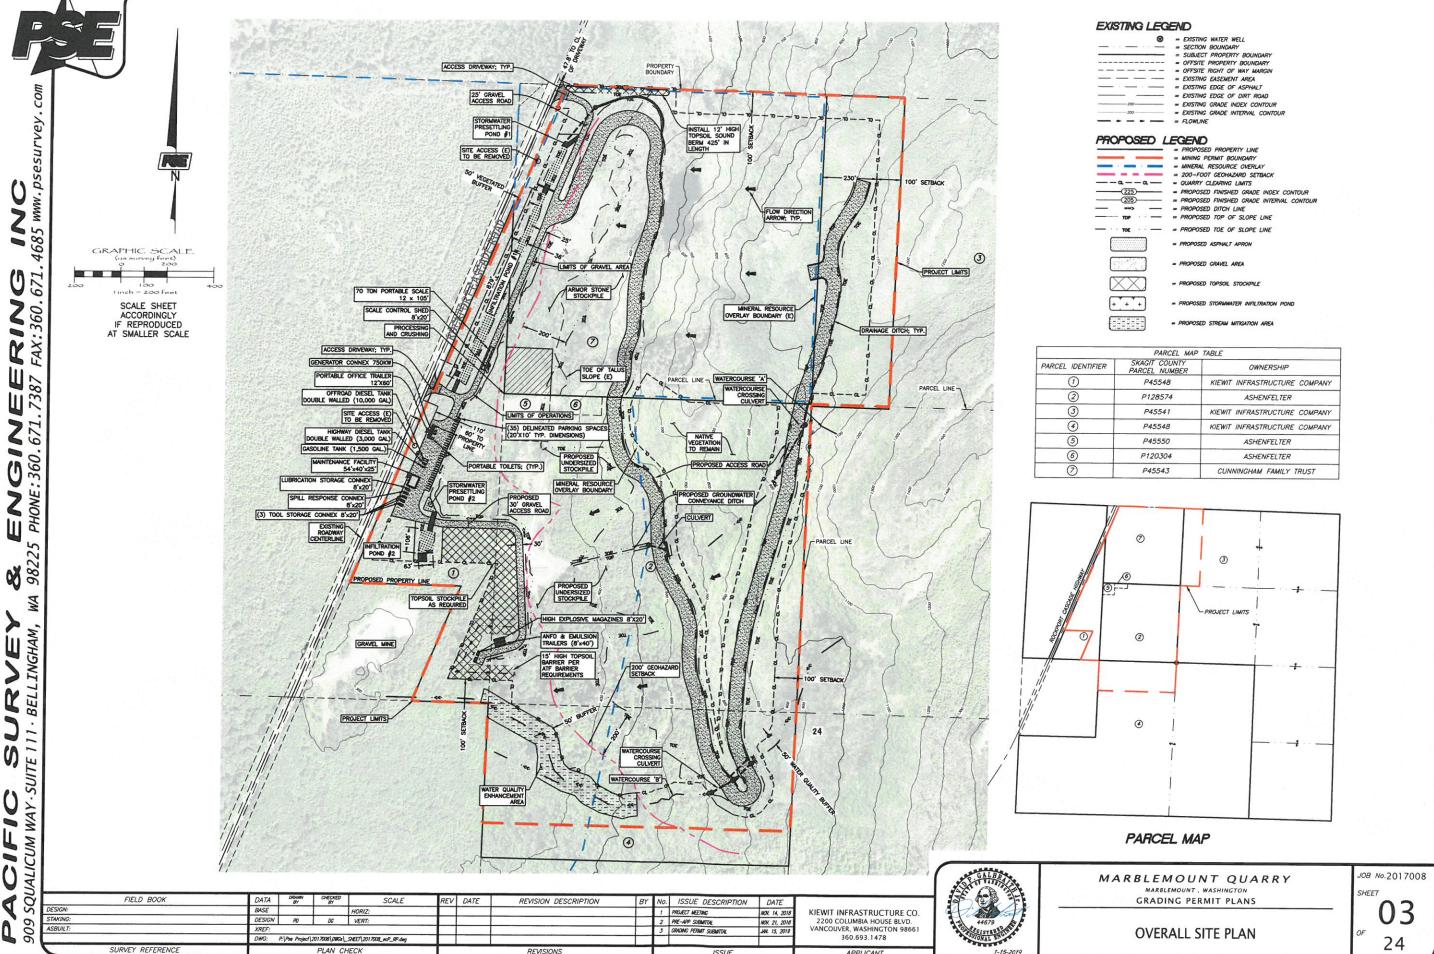
KIEWIT INFRASTRUCTURE CO. 2200 COLUMBIA HOUSE BLVD. VANCOUVER, WASHINGTON 98661

MARBLEMOUNT QUARRY GRADING PERMIT PLANS

COVER

JOB No.2017008 SHEET



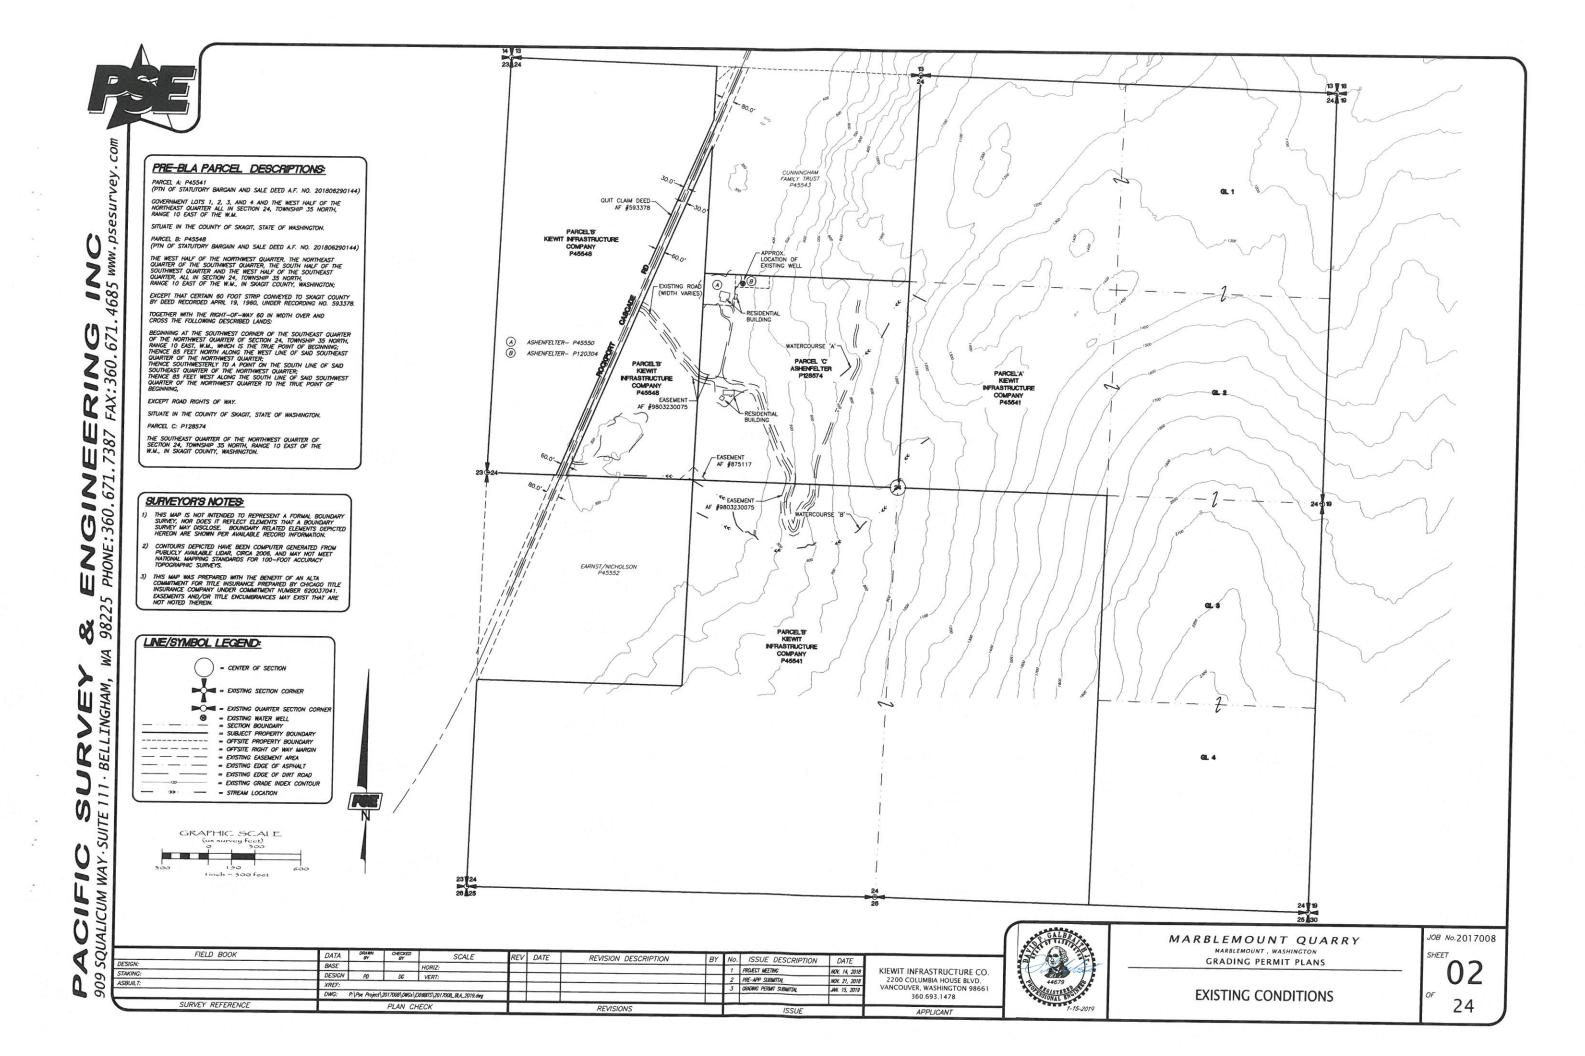

(DC) GRAPHIC SCALE **←** ⟨vc⟩ **EROSION CONTROL LEGEND** -a--a-- PROPOSED CLEARING/GRUBBING LIMITS - CONVEYANCE DITCHLINE - PROPOSED GRADING TOP OF SLOPE LINE - PROPOSED GRADING TOE OF SLOPE LINE WSDOE BMP C101 & C102 PRESERVING NATURAL VEGETATION (C101) & BUFFER ZONES (C102) WSDOE BMP C105 STABILIZED CONSTRUCTION ENTRANCE WSDOE BMP C130 SURFACE ROUGHENING WSDOE BMP C140 DUST CONTROL WSDOE BMP C152 SAWCUTTING AND SURFACING POLLUTION PREVENTION WSDOE BMP C208 GRAVEL CHECK DAM (MAX. 50 LF ON CENTER) WSDOE BMP C209 ROCK LINING OUTLET PROTECTION (OP) TS) WSDOE BMP C125 TOPSOILING WSDOE BMP C220 STORM DRAIN INLET PROTECTION (vc) SEE STORM WATER MANAGEMENT REPORT FOR DETAILS -PROJECT LIMITS JOB No.2017008 MARBLEMOUNT QUARRY MARBLEMOUNT , WASHINGTON SHEET FIELD BOOK GRADING PERMIT PLANS REVISION DESCRIPTION No. ISSUE DESCRIPTION DATE 1 PROJECT MEETING
2 PRE-APP SUBMITTAL
3 GRADING PERMIT SUBMITTAL KIEWIT INFRASTRUCTURE CO. 2200 COLUMBIA HOUSE BLVD. VANCOUVER, WASHINGTON 98661 NOV. 21, 2018 JAN. 15, 2019 **TEMPORARY EROSION AND**

REVISIONS

360.693.1478

SEDIMENTATION CONTROL PLAN

24

SURVEY REFERENCE

360.671.


GRAPHIC SCALE INC 4685 www.psesurvey.com 85+75 SHEET 09 -SHEET 15 -ROADWAY PLAN **ROADWAY PLAN** 20+00 TO 30+00 80+00 TO 80+60 SHEET 06 - SITE IMPROVEMENTS ENGINEERING
PHONE: 360.671.7387 FAX: 360.671. SHEET 14 -SHEET 10 -**ROADWAY PLAN ROADWAY PLAN** 70+00 TO 80+00 30+00 TO 40+00 SHEET 07 - SITE IMPROVEMENTS SOUTH SHEET 13 -**ROADWAY PLAN 8 9** 98225 61+30 TO 70+00 SHEET 11 -**ROADWAY PLAN** 40+00 TO 50+70 M SHEET 08 - SITE **IMPROVEMENTS** EAST SHEET 12 -**ROADWAY PLAN** 50+70 TO 61+30 JOB No.2017008 MARBLEMOUNT QUARRY MARBLEMOUNT , WASHINGTON SHEET FIELD BOOK GRADING PERMIT PLANS SCALE REVISION DESCRIPTION REV DATE BY No. ISSUE DESCRIPTION KIEWIT INFRASTRUCTURE CO. 2200 COLUMBIA HOUSE BLVD. VANCOUVER, WASHINGTON 98661 1 PROJECT MEETING
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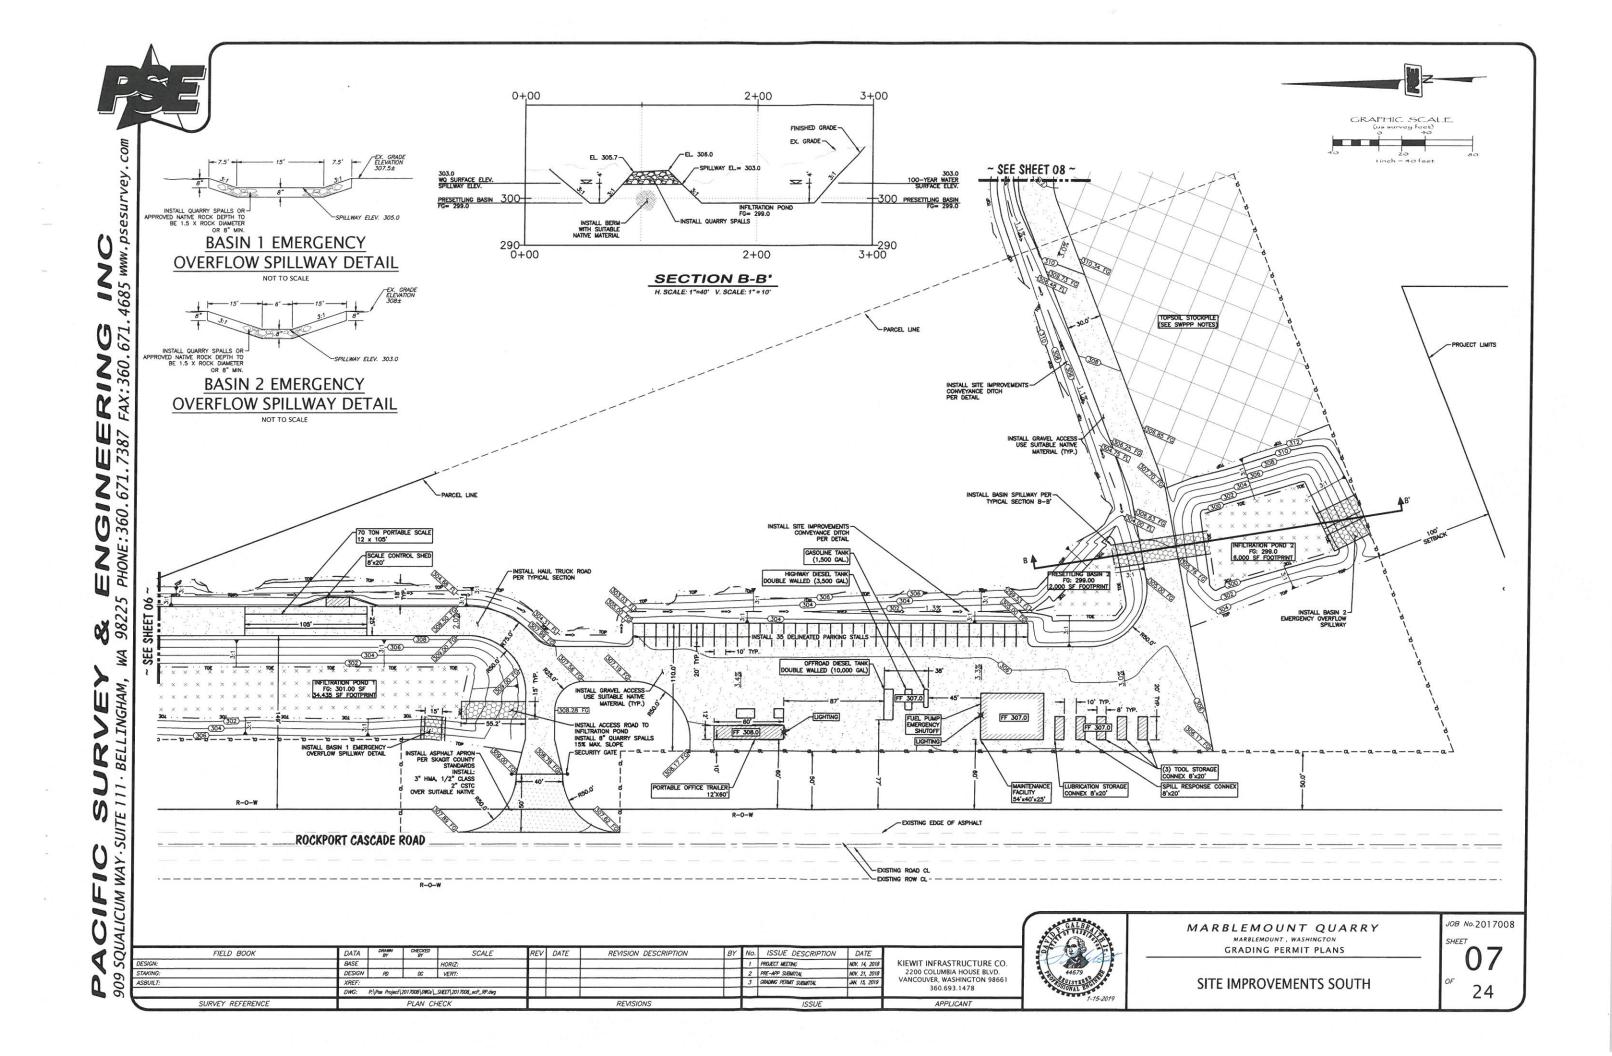
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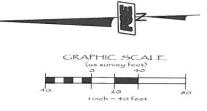
PLAN CHECK


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STAKING:	DESIGN	PO	DC	VERT:						2	PRE-APP SUBMITTAL	NOV. 21, 2018	2200 COLUMBIA HOUSE BLVD.
ASBUILT:	XREF:							100		3	GRADING PERMIT SUBMITTAL	JW. 15, 2019	VANCOUVER, WASHINGTON 98661
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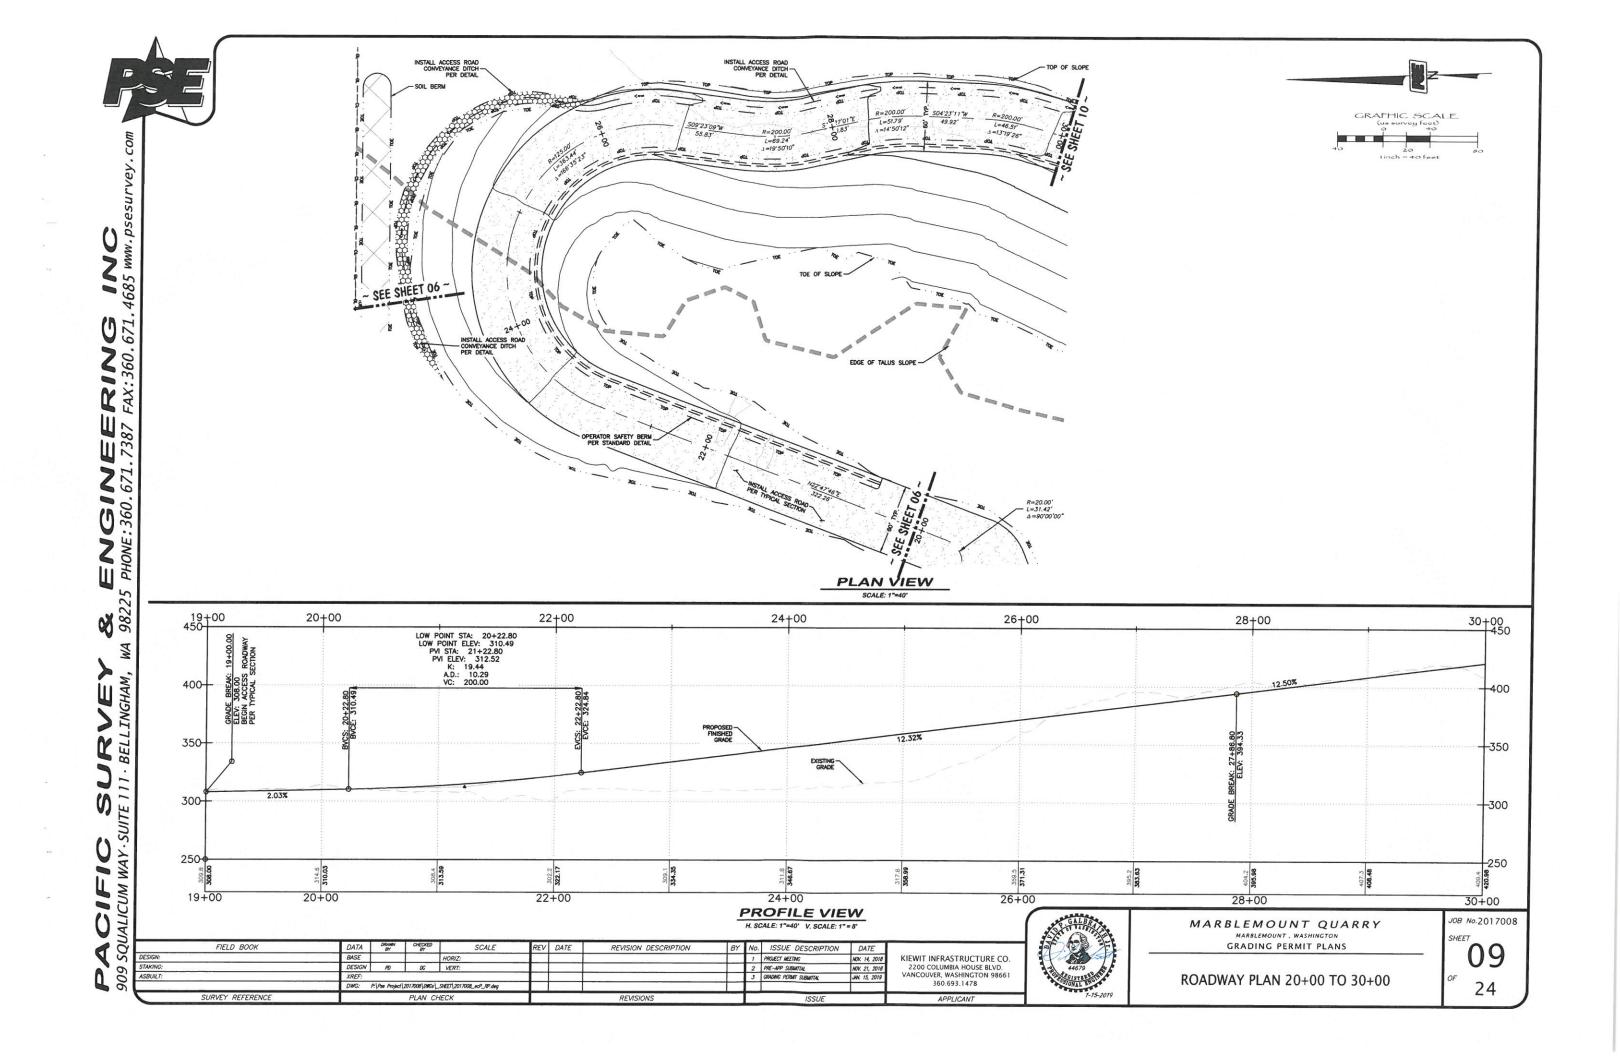
MARBLEMOUNT QUARRY


MARBLEMOUNT, WASHINGTON


GRADING PERMIT PLANS


SITE IMPROVEMENTS EAST

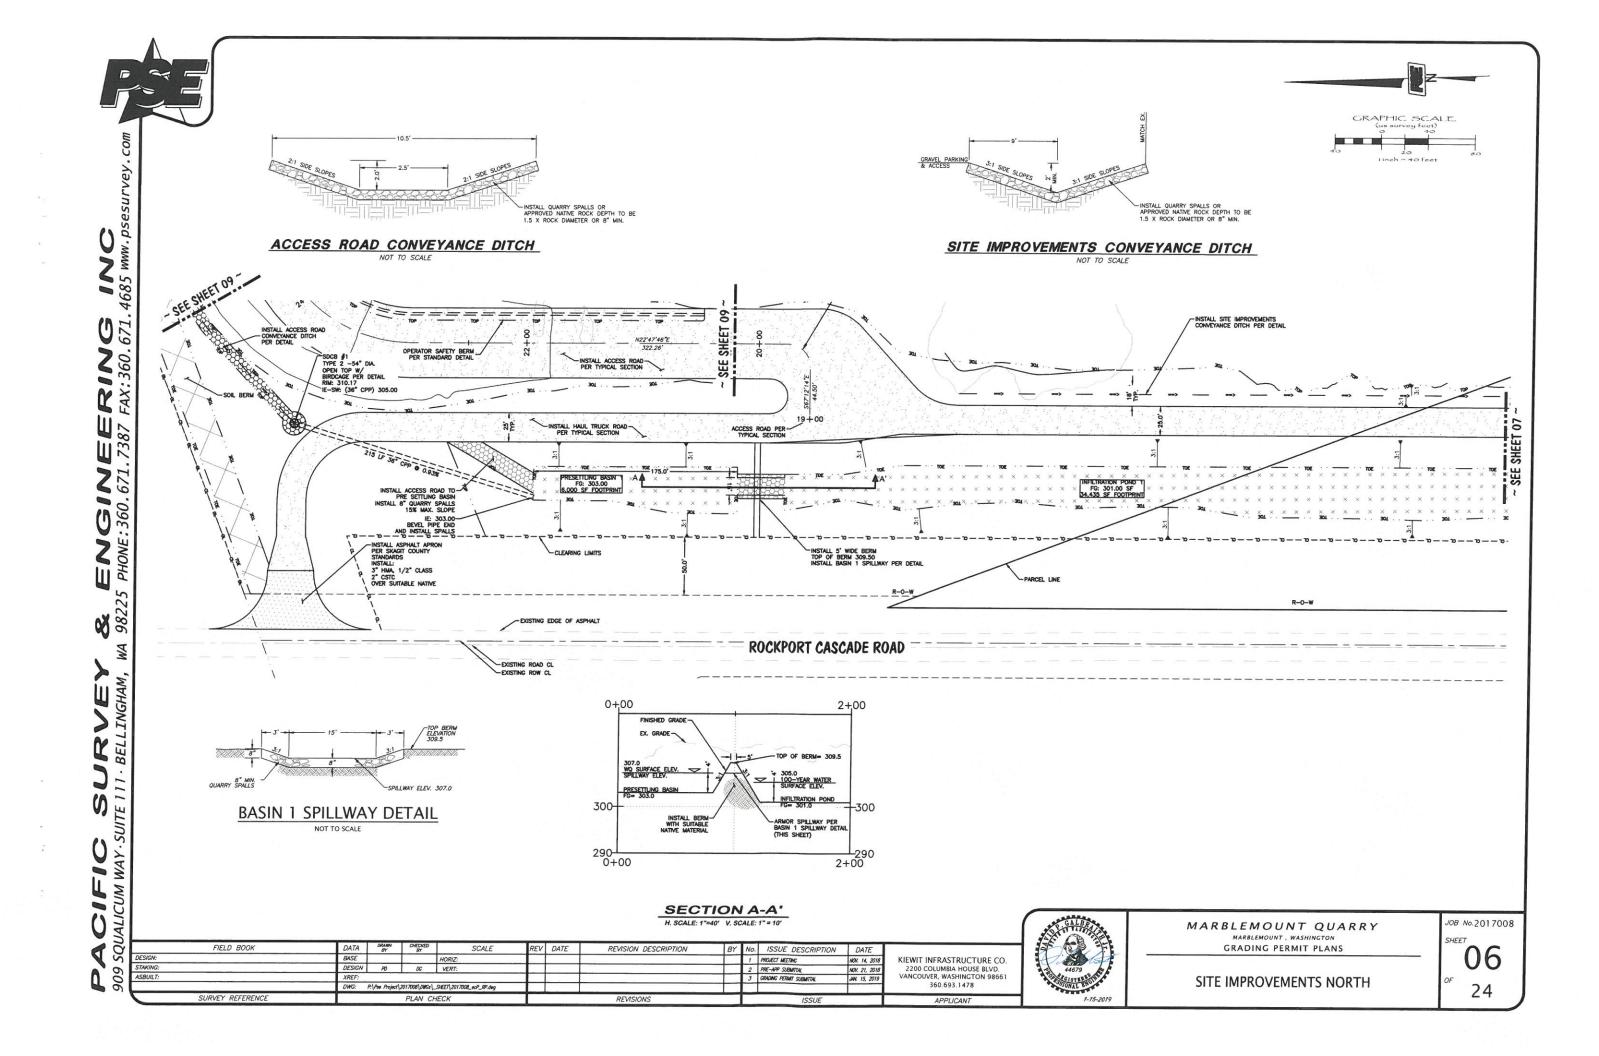
JOB No.2017008 SHEET

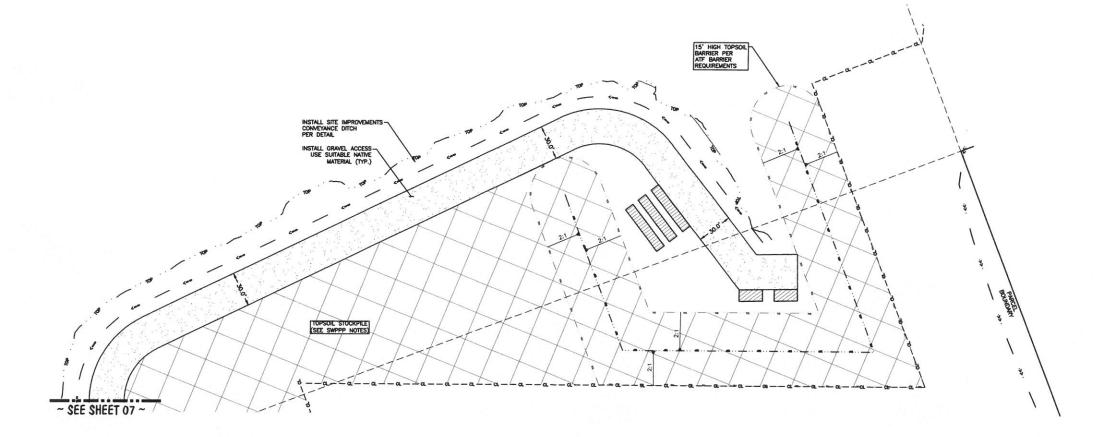


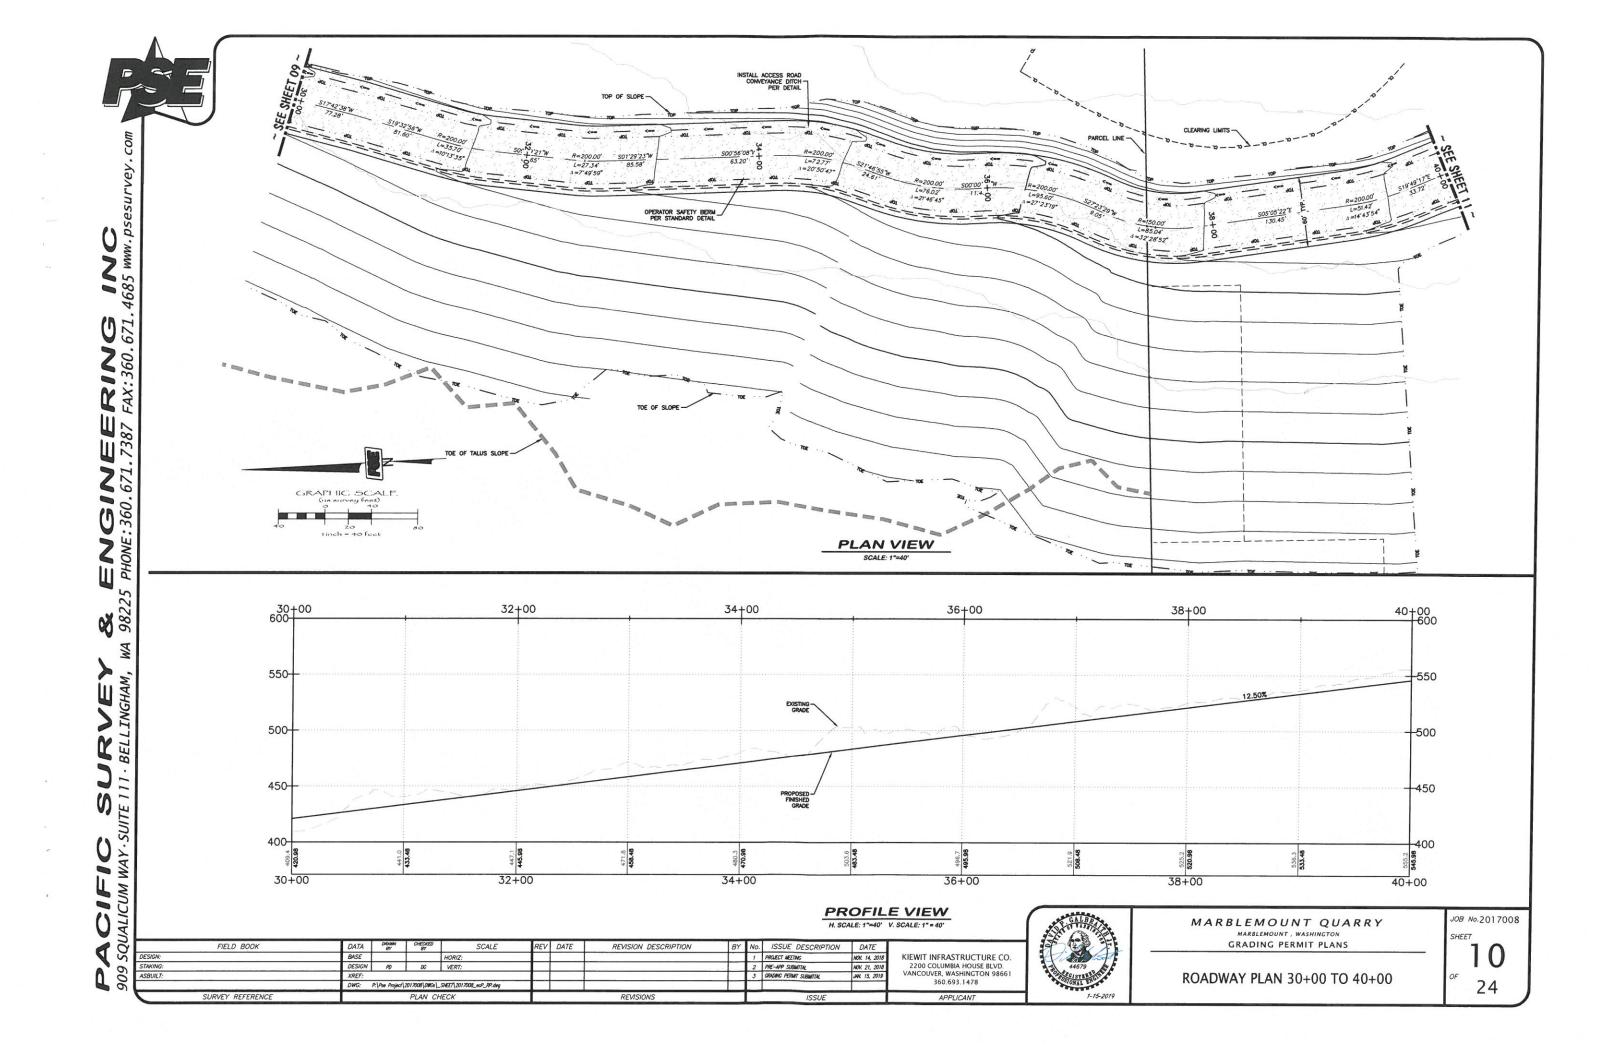

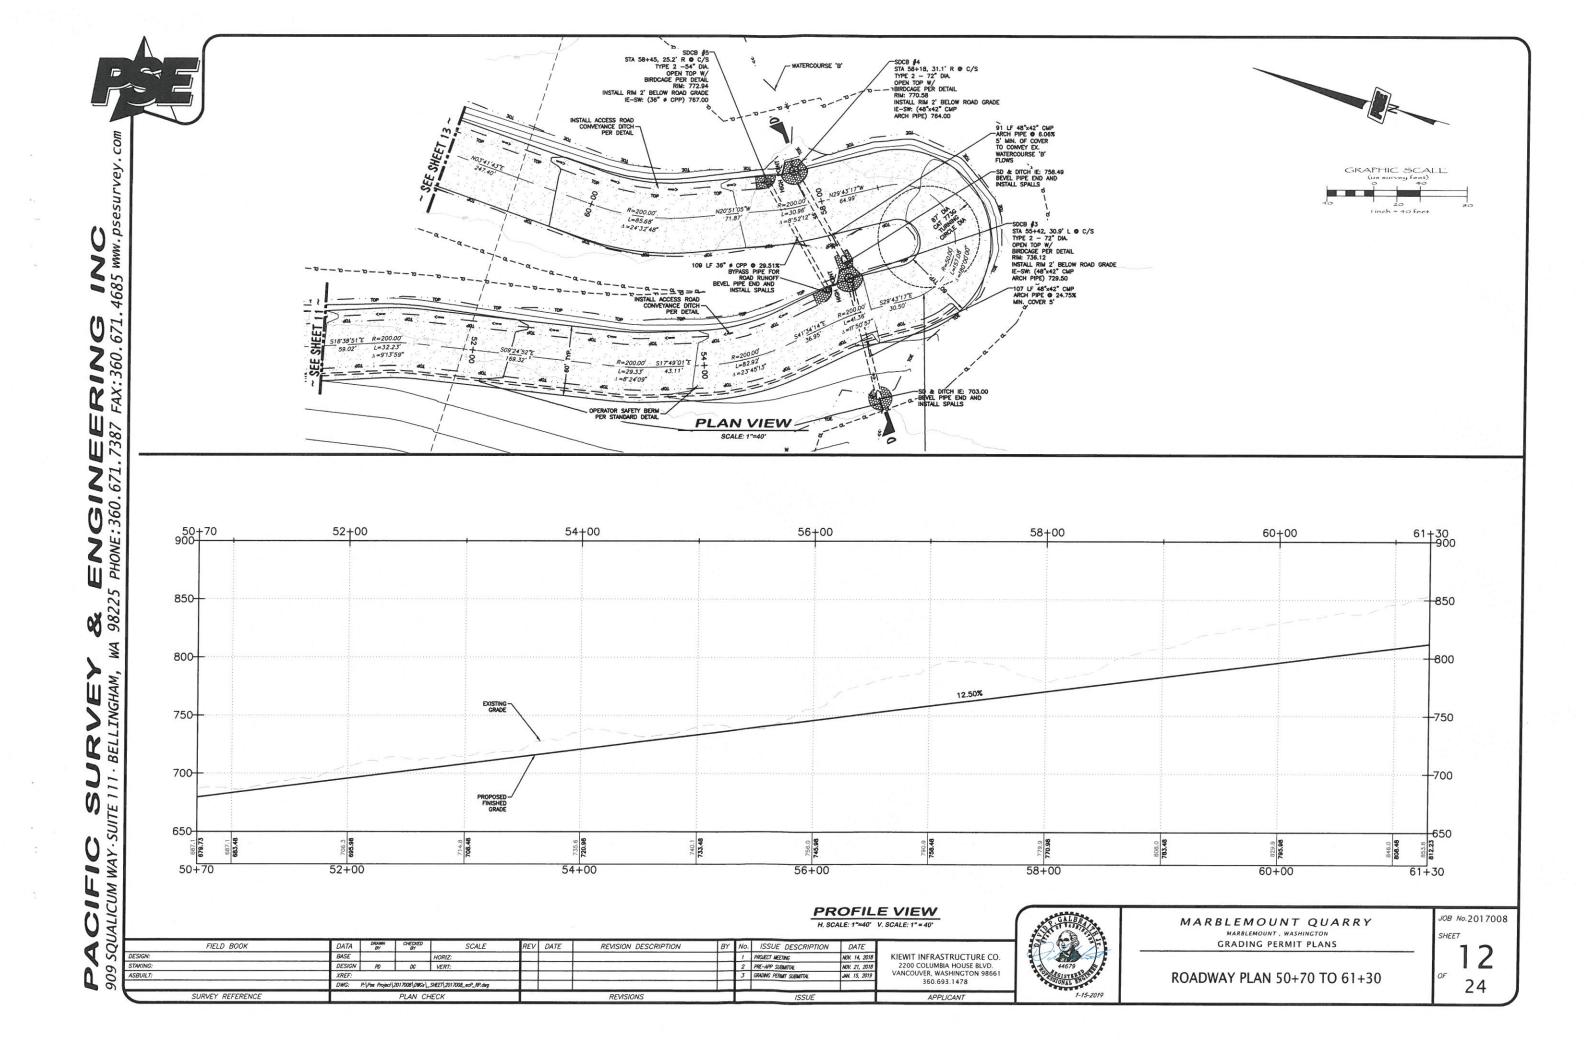

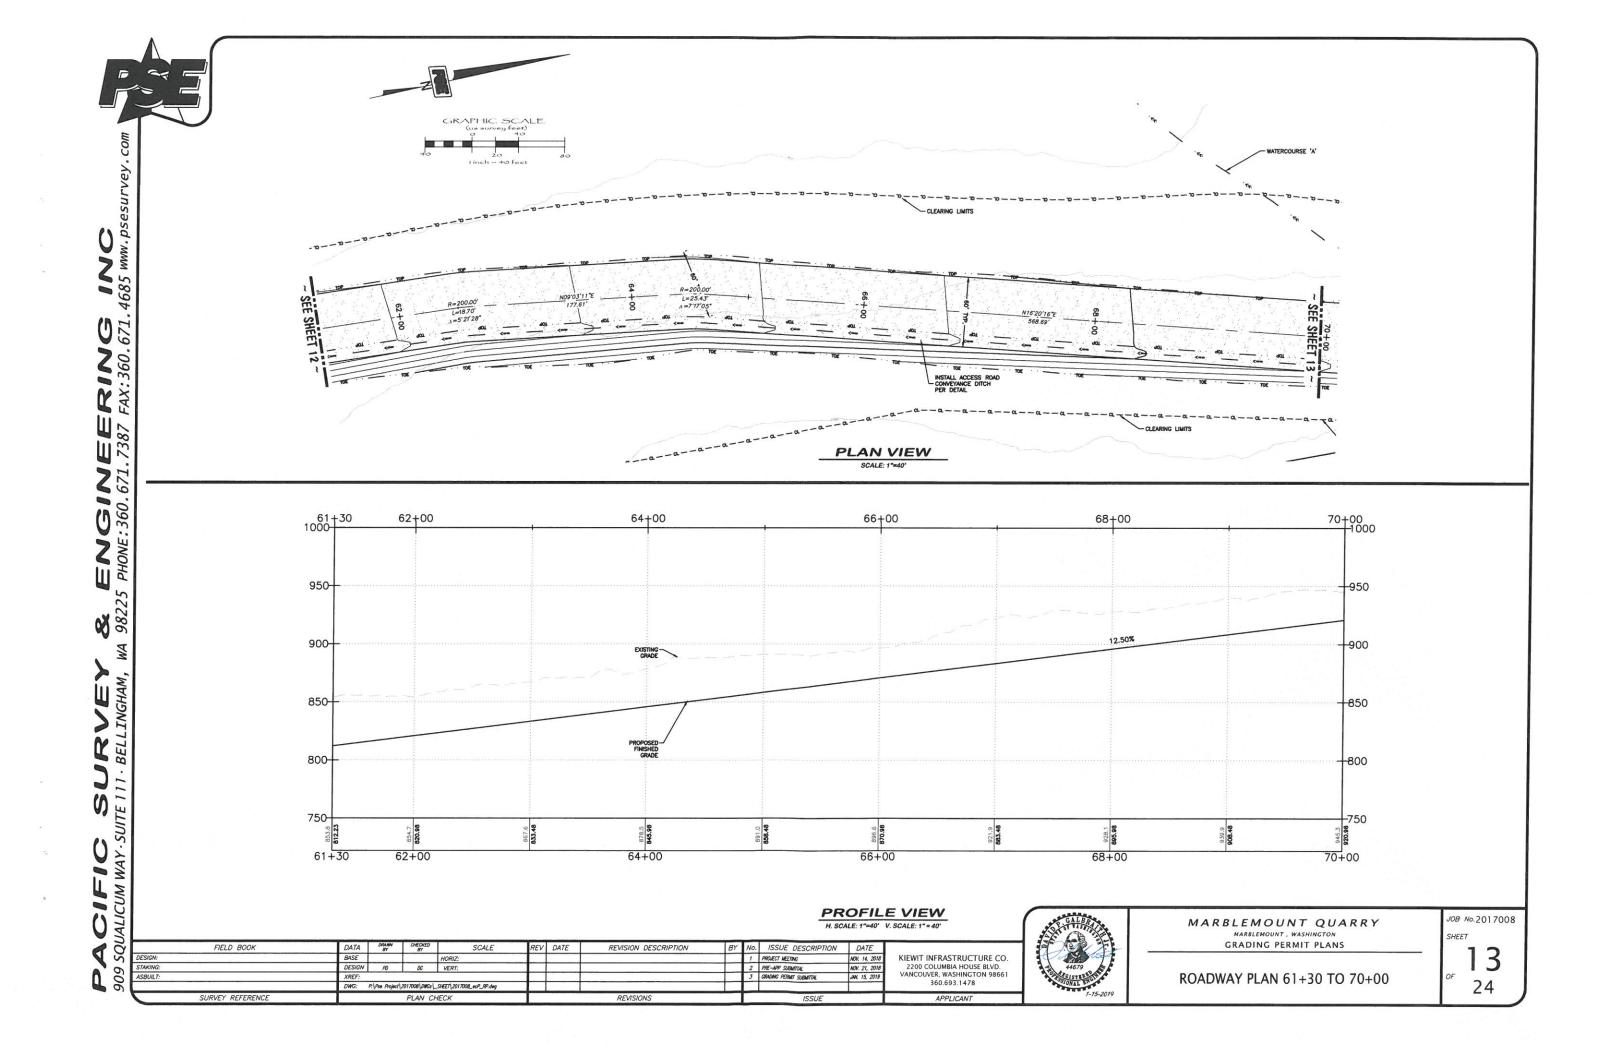

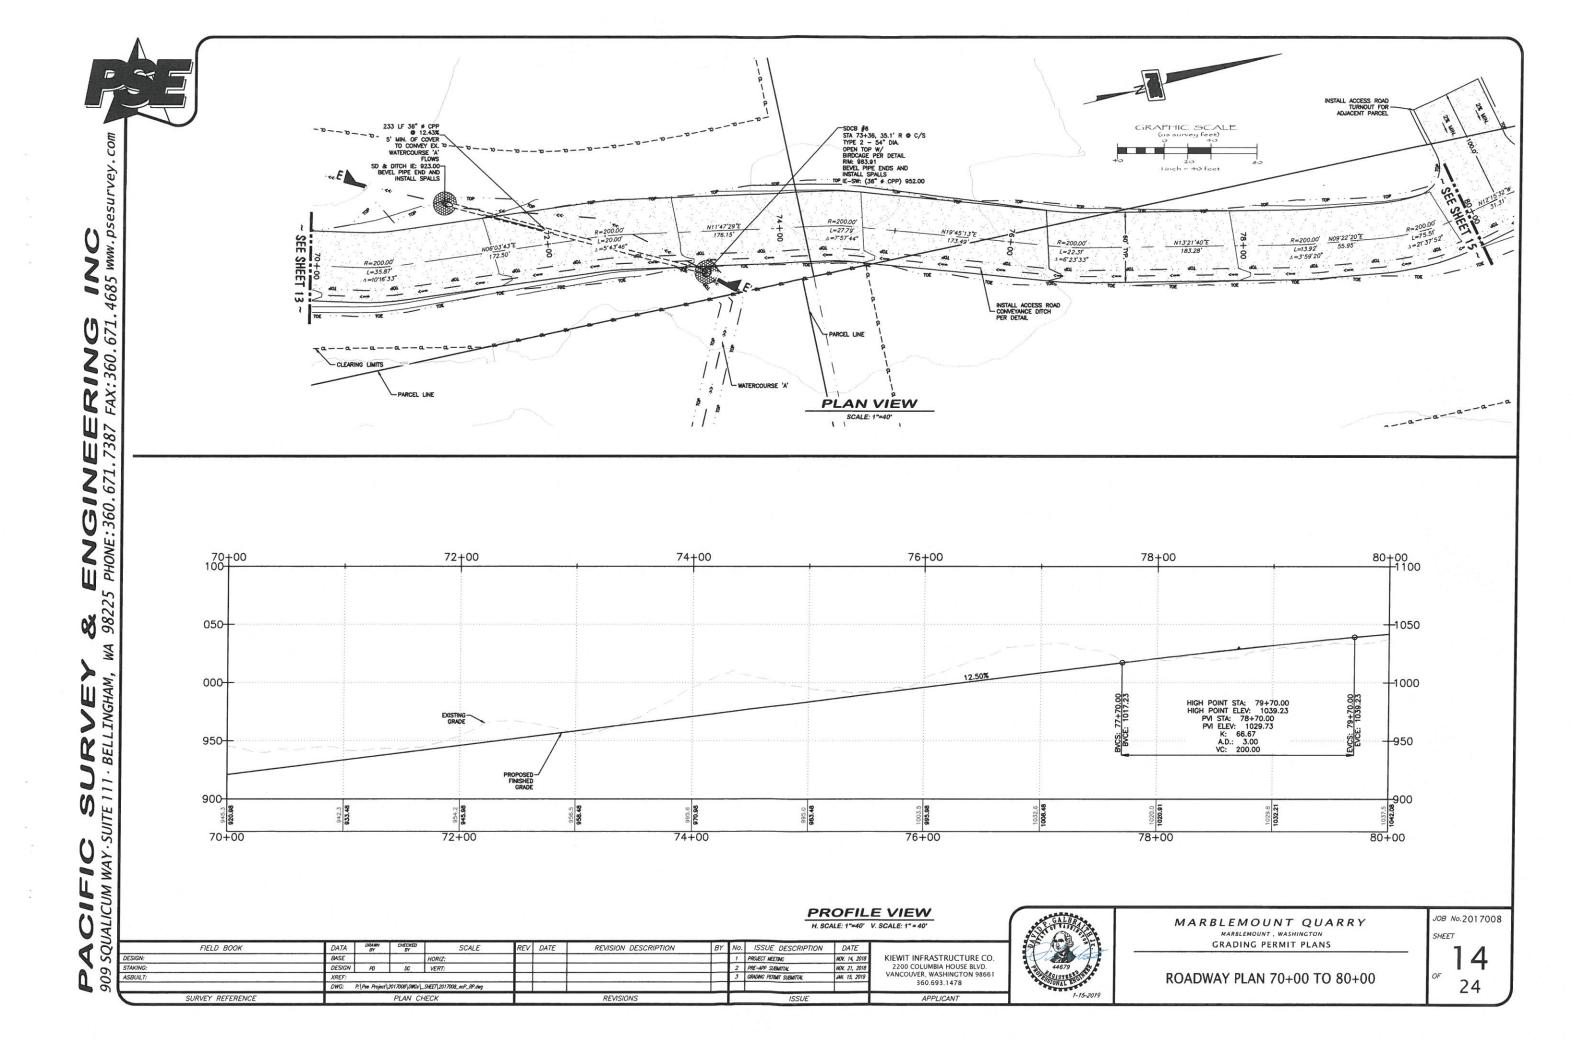

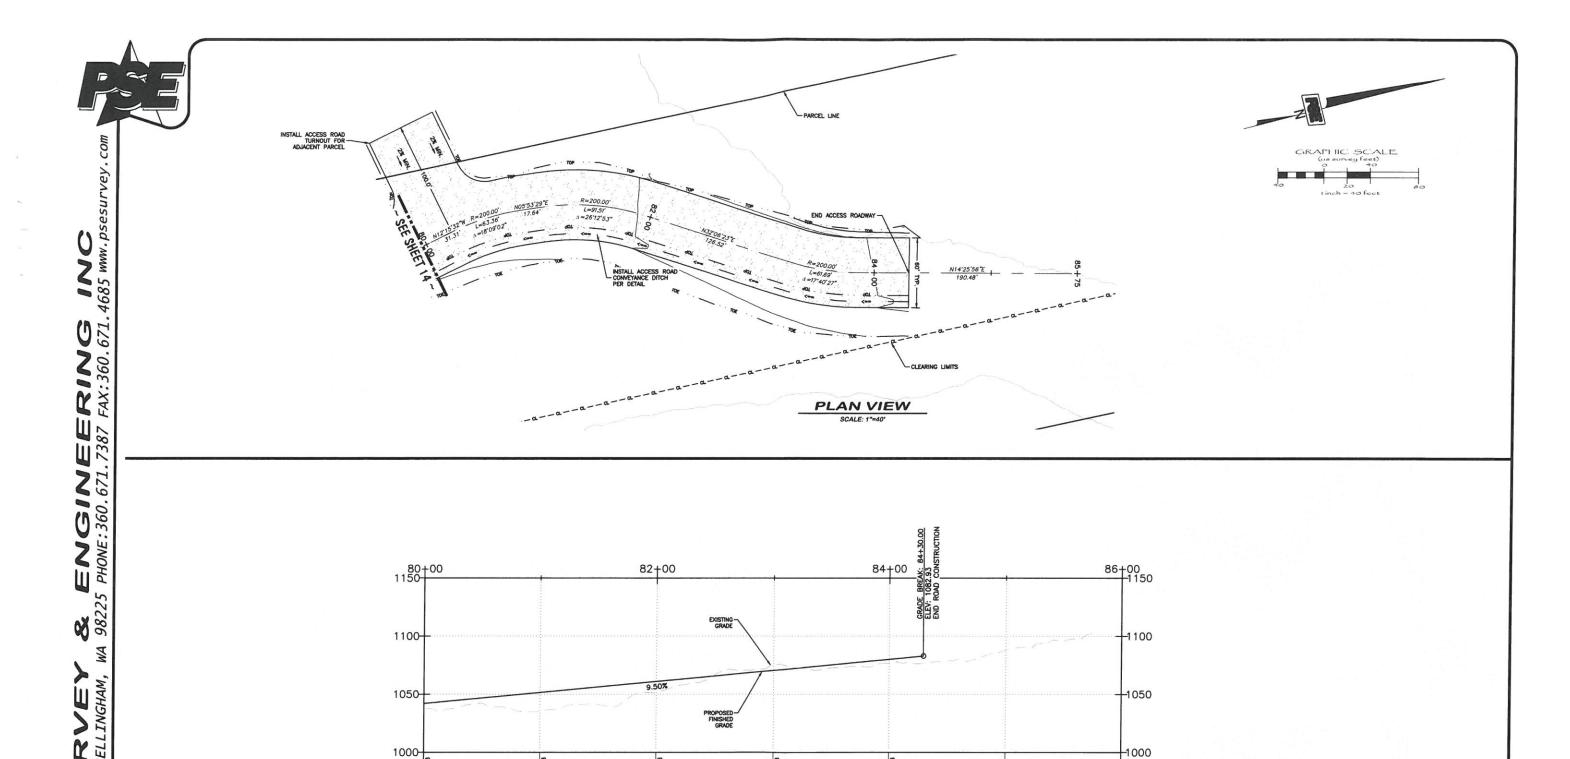

PROFILE VIEW H. SCALE: 1"=40' V. SCALE: 1" = 40'

84+00

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7	DESIGN:	BASE			HORIZ:					1	PROJECT MEETING	NOV. 14, 2018	KIEWIT INFRASTRUCTURE CO.	34
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3	ASBUILT:	XREF:								3	GRADING PERMIT SUBMITTAL	JAN. 15, 2019	VANCOUVER, WASHINGTON 98661	1 3
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82+00

80+00



86+00

MARBLEMOUNT QUARRY MARBLEMOUNT, WASHINGTON
GRADING PERMIT PLANS

JOB No.2017008 SHEET

24

ROADWAY PLAN 80+00 TO 80+60

& ENGINEERING INC 98225 PHONE: 360.671.7387 FAX: 360.671.4685 www.psesurvey.com

0+00 750 700 |700 MATCH EX. GRADE-650 650 PROPOSED OPERATOR SAFETY BERM-600 600 77 LF 36" # CPP 550 550 500 500 450-450 400-400 350 -350 418.9 524.5 619.6 1+00 0+00 2+00 3+00 4+00 4+25 SECTION C-C'

H. SCALE: 1"=20' V. SCALE: 1" = 40'

2+00

FIELD BOOK	DATA	DRAWN	CHECKED	SCALE	REV	DATE	REVISION DESCRIPTION	BY	No.	ISSUE DESCRIPTION	DATE	
DESIGN:	BASE			HORIZ:					1	PROJECT MEETING	NOV. 14, 2018	KIEWIT INFRASTRUCTURE CO.
STAKING:	DESIGN	PD	DG	VERT:					2	PRE-APP SUBMITTAL	NOV. 21, 2018	2200 COLUMBIA HOUSE BLVD.
ASBUILT:	XREF:								3	GRADING PERMIT SUBMITTAL	JAN. 15, 2019	VANCOUVER, WASHINGTON 98661
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1+00



3+00


MARBLEMOUNT QUARRY
MARBLEMOUNT, WASHINGTON GRADING PERMIT PLANS


4+,00

WATERCOURSE CROSSING SECTION C-C

JOB No.2017008 SHEET

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SECTION E-E'

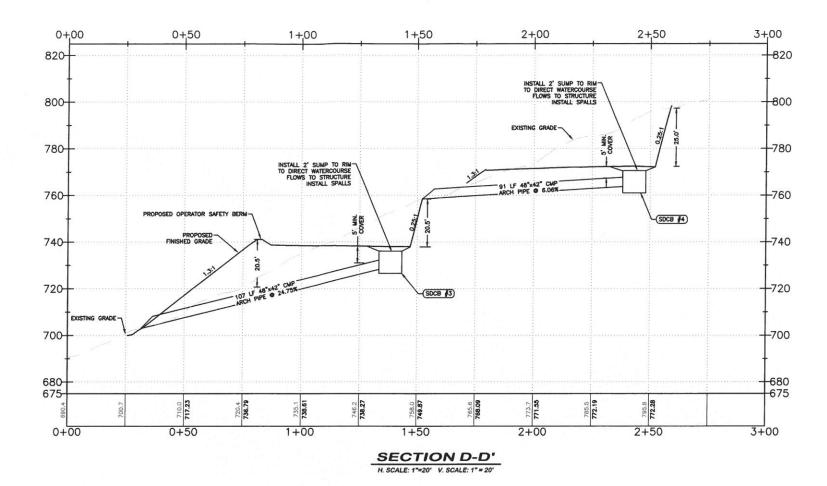H. SCALE: 1"=20" V. SCALE: 1" = 20"

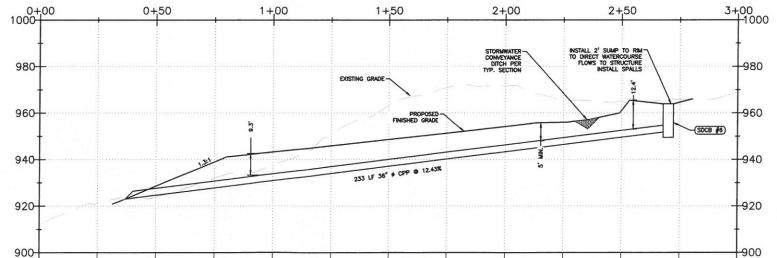2+00

1+50

FIELD BOOK	DATA	DRAHN	CHECKED	SCALE	REV	DATE	REVISION DESCRIPTION	BY	No.	ISSUE DESCRIPTION	DATE	
DESIGN:	BASE			HORIZ:					1	PROJECT MEETING	NOV. 14, 2018	KIEWIT INFRASTRUCTURE CO.
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0+00

0+50

1+00



2+50

MARBLEMOUNT QUARRY

MARBLEMOUNT, WASHINGTON

GRADING PERMIT PLANS

WATERCOURSE CROSSINGS SECTIONS D & E JOB No.2017008 SHEET



GENERAL NOTES

- ALL WORK AND MATERIALS SHALL BE IN ACCORDANCE WITH CURRENT WSDOT/APWA STANDARD SPECIFICATIONS, APPLICABLE DEVELOPMENT STANDARDS, AND SHALL BE SUBJECT TO APPROVAL BY THE ENGINEER.
- 2. SIGHT DISTANCE REQUIRED AT ALL INTERSECTIONS PER THE CURRENT WSDOT
- 3. A REVOCABLE ENCROACHMENT PERMIT SHALL BE OBTAINED PRIOR TO COMMENCING WORK WITHIN THE RIGHT-OF-WAY.
- 4. THE CONTRACTOR SHALL CONTACT UTILITY LOCATION SERVICE 48 HOURS PRIOR TO STARTING CONSTRUCTION AT 1-800-424-5555.
- 5. STORM PIPE SHALL BE AN APPROVED MATERIAL AND SIZE NOTED ON THE PLANS.
- 6. THE CONTRACTOR SHALL RIP RAP OR SUITABLE NATIVE ROCK ALL CULVERT INLETS AND OUTLETS.
- 7. CONTRACTOR SHALL SWEEP WITH PICK-UP SWEEPER AND REMOVE ALL DEBRIS TRACKED ONTO EXISTING ROADS DURING ALL PHASES OF CONSTRUCTION.
- 8. THE CONTRACTOR SHALL INFORM THE PROJECT ENGINEER AND OBTAIN APPROVAL OF ANY PROPOSED CHANGES IN PLANS PRIOR TO CONSTRUCTION OF THE CHANGE. THE CONTRACTOR SHALL KEEP RECORDS OF DEVIATIONS AND FORWARD
- 9. TRAFFIC CONTROL IS TO BE MAINTAINED IN ACCORDANCE WITH WSDOT/APWA STANDARD SPECIFICATIONS.
- 10. A COPY OF THE APPROVED PLANS MUST BE ON THE JOB SITE WHENEVER CONSTRUCTION IS IN PROCESS.
- 11. THE LOCATIONS OF EXISTING UNDERGROUND UTILITIES ARE SHOWN IN AN APPROXIMATE WAY ONLY AND HAVE NOT BEEN INDEPENDENTLY VERIFIED BY THE OWNER OR ITS REPRESENTATIVE THE CONTRACTOR SHALL DETERMINE THE EXACT LOCATION OF ALL EXISTING UTILITIES BEFORE COMMENCING WORK, AND AGREES TO BE FULLY RESPONSIBLE FOR ANY AND ALL DAMAGES WHICH MIGHT BE OCCASIONED BY THE CONTRACTOR'S FAILURE TO EXACTLY LOCATE AND PRESERVE ANY AND ALL UNDERGROUND UTILITIES.
- 12. WHEN THE CONTRACTOR CONSIDERS THE WORK PHYSICALLY COMPLETE AND READY FOR FINAL INSPECTION, THE CONTRACTOR SHALL REQUEST THAT THE ENGINEER OF RECORD SCHEDULE A FINAL INSPECTION. THE ENGINEER WILL MAKE A FINAL INSPECTION AND NOTIFY THE CONTRACTOR IN WRITING OF ALL PARTICULARS IN WHICH THE FINAL INSPECTION REVEALS THE WORK INCOMPLETE OR UNACCEPTABLE. THE CONTRACTOR SHALL IMMEDIATELY TAKE SUCH CORRECTIVE MEASURES AS ARE NECESSARY TO REMEDY THE LISTED DEFICIENCIES.
- 13. THE CONTRACTOR SHALL BE RESPONSIBLE FOR PROVIDING ADEQUATE SAFEGUARDS, SAFETY DEVICES, PROTECTIVE EQUIPMENT, FLAGGERS, AND ANY OTHER NEEDED ACTIONS TO PROTECT THE LIFE, HEALTH AND SAFETY OF THE PUBLIC, AND TO PROTECT PROPERTY IN CONNECTION WITH THE PERFORMANCE OF WORK COVERED BY THE CONTRACTOR. ANY WORK WITHIN THE TRAVELED RIGHT-OF-WAY THAT MAY INTERRUPT NORMAL TRAFFIC FLOW SHALL REQUIRE AT LEAST ONE FLAGGER FOR EACH LANE OF TRAFFIC AFFECTED. ALL SECTIONS OF THE WSDOT STANDARD SPECIFICATIONS 1-10 TRAFFIC CONTROL, SHALL APPLY.
- 14. THE CONTRACTOR SHALL CLEAR, GRUB AND CLEAN UP THOSE AREAS SHOWN ON THE PLANS.
- 15. THE CONTRACTOR SHALL RAZE, REMOVE AND DISPOSE OF ALL BUILDING AND FOUNDATIONS, STRUCTURES, FENCES AND OTHER OBSTRUCTIONS THAT LIE WHOLLY OR PARTIALLY WITHIN THE
- 16. THE CONTRACTOR SHALL EXCAVATE AND GRADE TO THE ALIGNMENT, GRADE AND CROSS-SECTIONS SHOWN IN THE PLANS OR ESTABLISHED BY THE ENGINEER
- 17. UNSUITABLE MATERIAL NOT FIT FOR A SUB-GRADE SHALL BE EXCAVATED TO THE BOUNDARIES SET BY THE ENGINEER AND REPLACED WITH A SUITABLE BACKFILL MATERIAL.
- 18. ALL PIPE AND APPURTENANCES SHALL BE LAID ON A PROPERLY PREPARED FOUNDATION IN ACCORDANCE WITH WSDOT STANDARD SPECIFICATIONS SECTION 7-08.3(1). THIS SHALL INCLUDE LEVELING AND COMPACTING THE TRENCH BOTTOM, THE TOP OF THE FOUNDATION MATERIAL AND ANY REQUIRED PIPE BEDDING TO A UNIFORM GRADE SO THAT THE ENTIRE PIPE IS SUPPORTED BY A UNIFORMLY DENSE UNYIELDING BASE. DRAINAGE MATERIALS SHALL CONFORM TO WSDOT STANDARD SPECIFICATIONS SECTION 9-05.
- 19. STORM SEWER PIPE HAVING DIAMETERS GREATER THAN 8" SHALL BE CORRUGATED POLYETHYLENE PIPE (CPP) AND SHALL CONFORM TO WSDOT STANDARD SPECIFICATIONS, SECTION 9-05.20. STORM SEWER PIPE HAVING DIAMETERS 8" AND SMALLER SHALL BE POLYVINYL CHLORIDE (PVC) PIPE, ASTM D 3034, SDR 35, AND SHALL CONFORM TO WSDOT STANDARD SPECIFICATIONS, SECTION 9-05.12(1).

20. PAVEMENTS

- A. A TACK COAT OF ASPHALT SHALL BE APPLIED BETWEEN ALL COURSES OF ASPHALT.
- B. ALL PAVEMENT REPAIR SHALL BE SAW-CUT BEFORE REMOVAL. AR-4000W SHALL BE APPLIED TO ALL EDGES OF EXISTING PAVEMENT.
- C. WHERE NEWLY CONSTRUCTED PAVING MEETS EXISTING PAVING, THE APPLICANT SHALL PROVIDE A SMOOTH TRANSITION FROM EXISTING TO PROPOSED PAVING. CONTRACTOR SHALL BUTT JOINT PER DIMENSIONS SPECIFIED
- D. ALL PAVEMENT MARKINGS SHALL CONFORM TO THE REQUIREMENTS OF THE MUTCD.

FIELD BOOK	DATA	DRAWN BY	CHECKED	SCALE	REV	DATE	REVISION DESCRIPTION	BY	No.	ISSUE DESCRIPTION	DATE	
DESIGN:	BASE			HORIZ:					1	PROJECT MEETING	NOV. 14, 2018	ŀ
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SURVEY REFERENCE			PLAN CI	HECK			REVISIONS		П	ISSUE		



KIEWIT INFRASTRUCTURE CO. 2200 COLUMBIA HOUSE BLVD

> 360.693.1478 APPLICANT

MARBLEMOUNT, WASHINGTON

GENERAL NOTES

IOB No.2017008 SHEET

8

MARBLEMOUNT QUARRY GRADING PERMIT PLANS

S www 468 212 982 MA BELL INGHAM, WAY. -

606

ASBUILT:

TEMPORARY EROSION/SEDIMENTATION CONTROL

- A COPY OF THESE APPROVED PLANS MUST BE ON THE JOB SITE WHENEVER CONSTRUCTION IS IN PROGRESS.
- APPROVAL OF THESE TEMPORARY EROSION/SEDIMENTATION CONTROL (TESC) PLANS DOES NOT CONSTITUTE AN APPROVAL OF PERMANENT ROAD OR DRAINAGE DESIGN (E.G., SIZE AND LOCATION OF ROADS, PIPES, RESTRICTORS, CHANNELS, RETENTION FACILITIES, UTILITIES, ETC.).
- THE IMPLEMENTATION OF THESE TESC PLANS AND THE CONSTRUCTION, MAINTENANCE, REPLACEMENT AND UPGRADING OF THESE TESC FACILITIES IS THE RESPONSIBILITY OF THE CONTRACTOR UNTIL ALL CONSTRUCTION IS APPROVED.
- 4. THE BOUNDARIES OF THE CLEARING LIMITS SHOWN ON THIS PLAN SHALL BE CLEARLY FLAGGED IN THE FIELD PRIOR TO CONSTRUCTION. DURING THE CONSTRUCTION PERIOD, NO DISTURBANCE BEYOND THE FLAGGED CLEARING LIMITS SHALL BE PERMITTED. THE FLAGGING SHALL BE MAINTAINED BY THE CONTRACTOR FOR THE DURATION OF CONSTRUCTION.
- 5. THE TESC FACILITIES SHOWN ON THE PLANS MUST BE CONSTRUCTED IN CONJUNCTION WITH ALL CLEARING AND GRADING ACTIVITIES, AND IN SUCH A MANNER AS TO INSURE THAT SEDIMENT LADEN WATER DOES NOT ENTER THE DRAINAGE SYSTEM OR VIOLATE APPLICABLE WATER STANDARDS.
- 6. THE TESC FACILITIES SHOWN ON THE PLANS ARE THE MINIMUM REQUIREMENTS FOR ANTICIPATED SITE CONDITIONS. DURING THE CONSTRUCTION PERIOD, THESE TESC FACILITIES SHALL BE UPGRADED (E.G., ADDITIONAL SUMPS, RELOCATION OF DITCHES AND SILT FENCES, ETC.) AS NEEDED FOR UNEXPECTED STORM EYENTS.
- THE TESC FACILITIES SHALL BE INSPECTED DAILY BY THE CONTRACTOR AND MAINTAINED AS NECESSARY TO ENSURE THEIR CONTINUED FUNCTIONING. A RECORD OF EACH INSPECTION AND ANY CORRECTIVE ACTION TAKEN MUST BE RETAINED WITH THE SWPPP.
- THE TESC FACILITIES ON INACTIVE SITES SHALL BE INSPECTED AND MAINTAINED A MINIMUM OF ONCE A MONTH OR WITHIN THE 24 HOURS FOLLOWING A STORM EVENT WITH THE APPROVAL OF ENCINCED.
- AT NO TIME SHALL MORE THAN ONE FOOT OF SEDIMENT BE ALLOWED TO ACCUMULATE WITHIN A CATCH BASIN. ALL CATCH BASINS AND COMEYANCE LINES SHALL BE CLEANED PRIOR TO PAVING. THE CLEANING OPERATION SHALL NOT FLUSH SEDIMENT LIADEN WATER INTO THE DOWNSTREAM SYSTEM.
- 10. STABILIZED CONSTRUCTION ENTRANCES AND WASH PADS SHALL BE INSTALLED AT THE BEGINNING OF CONSTRUCTION AND MAINTAINED FOR THE DURATION OF THE PROJECT. ADDITIONAL MEASURES MAY BE REQUIRED TO INSURE THAT ALL PAYED AREAS ARE KEPT CLEAN FOR THE DURATION OF THE PROJECT.
- 11. ANY PERMANENT RETENTION/DETENTION FACILITY USED AS A TEMPORARY SETTLING BASIN SHALL BE MODIFIED WITH THE NECESSARY EROSION CONTROL MEASURES AND SHALL PROVIDE ADEQUATE STORAGE CAPACITY. IF THE PERMANENT FACILITY IS TO FUNCTION UNITMATELY AS AN INFILITATION OR DISPERSION SYSTEM, THE FACILITY SHALL NOT BE USED AS A TEMPORARY SETTLING BASIN. NO UNDEGROROUND DETENTION TANK, DETENTION AUGUST, OR SYSTEM WHICH BACKS UNDER OR INTO A POND SHALL BE USED AS A TEMPORARY SETTLING BASIN.
- 12. WHERE SEEDING FOR TEMPORARY EROSION CONTROL IS REQUIRED, FAST GERMINATING GRASSES SHALL BE APPLIED AT AN APPROPRIATE RATE (E.G. ANNUAL OR PERENNIAL RYE APPLIED AT APPROXIMATELY 120 POUNDS PER ACRE).
- 13. WHERE STRAW MULCH FOR TEMPORARY EROSION CONTROL IS REQUIRED, IT SHALL BE APPLIED AT A MINIMUM THICKNESS OF TWO INCHES.
- ALL EROSION/SEDIMENTATION CONTROL PONDS WITH A DEAD STORAGE DEPTH EXCEEDING 6 INCHES MUST HAVE SLOPES NOT STEEPER THAN 3H:1V.
- ALL WORK AND MATERIALS SHALL BE IN ACCORDANCE WITH WASHINGTON STATE DEPARTMENT OF TRANSPORTATION STANDARDS AND SPECIFICATIONS.
- 16. EROSION/SEDIMENTATION CONTROL FACILITIES SHALL BE CONSTRUCTED IN ACCORDANCE WITH THE DETAILS IN THESE PLANS LOCATIONS MAY BE MOVED TO SUIT FIELD CONDITIONS, SUBJECT TO APPROVAL BY THE ENGINEER AND LOCAL JURISDICTIONAL AUTHORITY.

NPDES NOTES

- THE CONTRACTOR SHALL KEEP A RECORD OF THE DATES WHEN MAJOR GRADING ACTIVITIES OCCUR, WHEN CONSTRUCTION ACTIVITIES TEMPORARILY OR PERMANENTLY CEASE ON A PORTION OF THE STEE, AND WHEN STABILIZATION MEASURES ARE IMPLEMENTED.
- 2. ALL EROSION CONTROL FACILITIES SHALL BE INSPECTED, MAINTAINED AND REPAIRED BY THE CONTRACTOR AS NEEDED TO ASSURE CONTINUED PERFORMANCE OF THEIR INTENDED FUNCTION. ALL ON STIE EROSION AND SEDIMENTATION CONTROL MEASURES SHALL BE INSPECTED AT LEAST ONCE EVERY SEVEN DAYS AND WITHIN 24 HOURS AFTER ANY STORM EVENT OF GREATER THAN 0.5 INCHES PER 24 HOUR PERIOD. AN INSPECTION REPORT FILE SHALL BE MAINTAINED BY THE CONTRACTOR FOR EACH INSPECTION.

SEEDING NOTES

FIELD BOOK

SURVEY REFERENCE

- 1. SEEDBED PREPARATION MAY INCLUDE THE FOLLOWING:
- A. IF INFERTILE OR COURSE TEXTURED SUBSOIL WILL BE EXPOSED DURING GRADING, STOCKPILE TOPSOIL AND RE-SPREAD IT OVER THE FINISHED SLOPE AND ROLL IT TO PROVIDE A FIRM BASE.
- B. IF CONSTRUCTION FILLS HAVE LEFT SOIL EXPOSED WITH A LOOSE, ROUGH OR IRREGULAR SURFACE, TRACK WALK UP SLOPE.
- C. IF CUTS OR CONSTRUCTION EQUIPMENT HAVE LEFT A TIGHTLY COMPACTED SURFACE, BREAK WITH CHISEL PLOW OR OTHER SUITABLE EQUIPMENT.
- D. PERFORM ALL CULTURAL OPERATIONS ACROSS OR AT RIGHT ANGLES TO THE SLOPES (CONTOURED). THE SEEDBED SHOULD BE FIRM WITH A FAIRLY FINE SURFACE AFTER ROUGHENING
- FERTILIZATION AS PER SUPPLIER'S RECOMMENDATIONS. DEVELOPMENTS ADJACENT TO WATER BODIES MUST USE NON-PHOSPHOROUS FERTILIZER.
- 3. HYDROSEEDING APPLICATIONS WITH APPROVED SEED-MULCH-FERTILIZER MIXTURES MAY ALSO BE USED.
- SEEDING APPLY APPROPRIATE MIXTURE TO THE PREPARED SEEDBED AT A RATE OF 120 LBS/ACRE. COVER THE SEED WITH TOPSOIL OR MULCH NO DEEPER THAN ONE—HALF INCH.

SEED MIX	VEGETATION TYPE (COMMON NAME)	PROPORTIONS BY WEIGHT	PERCENT PURITY	PERCENT GERMINATION
	CHEWINGS OR RED FESCUE	40%	98	90
TEMPORARY EROSION CONTROL* -	PERENNIAL RYE	50%	98	90
TEMPORARY ERUSION CONTROL*	REDTOP OR COLONIAL BENTGRASS	5%	92	85
	WHITE DUTCH CLOVER	5%	98	90
	DWARF TALL FESCUE VAR.	45%	98	90
LOW GROW*	DWARF PERENNIAL RYE (BARCLAY)	30%	98	90
LOW GROW-	RED FESCUE	20%	98	90
	COLONIAL BENTGRASS	5%	98	90

*(ADOPTED FROM WSDOE 2014 STORMWATER MANAGEMENT MANUAL WESTERN WASHINGTON, VOLUME. II, BMP C120)

PLAN CHECK

REVISION DESCRIPTION


REVISIONS

No. ISSUE DESCRIPTION

MOV. 21, 2018 JAN. 15, 2019

1 PROJECT MEETING

2 PRE-APP SUBMITTAL
3 GRADING PERMIT SUBMITTA

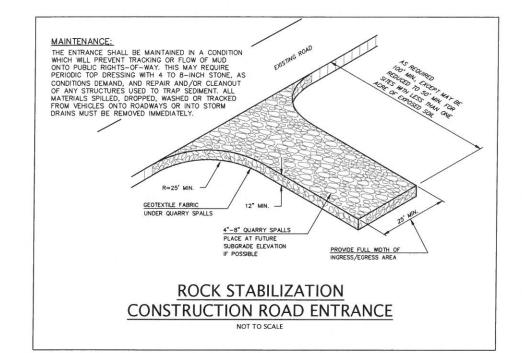

KIEWIT INFRASTRUCTURE CO.

2200 COLUMBIA HOUSE BLVD.

VANCOUVER, WASHINGTON 98661

APPLICANT

MARBLEMOUNT QUARRY

MARBLEMOUNT, WASHINGTON

GRADING PERMIT PLANS

JOB No.2017008 SHEET 19

24

TESC NOTES AND DETAILS

STORMWATER POLLUTION PREVENTION PLAN - 13 ELEMENTS

ELEMENT #1 ~ MARK CLEARING LIMITS

PRIOR TO THE COMMENCEMENT OF CONSTRUCTION ACTIVITIES, THE LIMITS OF THE CLEARING AREA WILL BE MARKED IN THE FIELD.

THE MINIMUM REQUIRED SOIL STABILIZING BMP'S ARE:

C101: PRESERVE NATURAL VEGETATION

C102: BUFFER ZONES

ELEMENT #2 ~ ESTABLISH CONSTRUCTION ACCESS

ACCESS POINTS SHALL BE STABILIZED WITH A PAD OF QUARRY SPALLS, CRUSHED ROCK, OR OTHER EQUIVALENT BMPS, TO MINIMIZE TRACKING OF SEDIMENT ONTO PUBLIC ROADS. IF SEDIMENT IS TRACKED OFF SITE, THE AFFECTED ROADWAY WILL BE CLEANED THOROUGHLY AT THE END OF EACH DAY, OR MORE FREQUENTLY AS NECESSARY (FO EXAMPLE, DURING WET WEATHER). SEDIMENT SHALL BE REMOVED FROM ROADS BY SHOVELING, SWEEPING, OR PICK UP AND TRANSPORT THE SEDIMENT TO A CONTROLLED SEDIMENT DISPOSAL AREA.

THE MINIMUM REQUIRED SOIL STABILIZING BMP'S ARE:

C105: STABILIZED CONSTRUCTION ENTRANCE

C125: TOPSOILING

PROPERTIES AND WATERWAYS DOWNSTREAM OF DEVELOPMENT SITES SHALL BE PROTECTED FROM EROSION AND THE ASSOCIATED DISCHARGE OF TURBID WATERS DUE TO INCREASES IN THE VELOCITY AND PEAK VOLUMETRIC FLOW RATE OF STORMWATER RUNOFF FROM THE PROJECT SITE. ALL STORMWATER RUNOFF WILL BE 100% INFILTRATED INTO THE EXISTING SITE.

SEDIMENT PONDS WILL BE INSTALLED AS ONE OF THE FIRST STEPS IN GRADING. STORMWATER RUNOFF FROM THE DISTURBED PORTIONS OF THE SITE SHALL BE ROUTED THROUGH STABILIZED CHANNELS, INCLUDING CHECK DAMS.

THE MINIMUM REQUIRED BMP ARE:

C208: GRAVEL CHECK DAM

ELEMENT #5 ~ STABILIZE SOILS

ALL EXPOSED AND UNWORKED SOILS SHALL BE STABILIZED BY APPLICATIONS OF EFFECTIVE BMP'S THAT PROTECT THE SOIL FROM THE EROSIVE FORCES OF RAINDROP IMPACT AND FLOWING WATER, AND WIND EROSION. SOIL STOCKPILES MUST BE STABILIZED FROM EROSION, PROTECTED WITH SEDIMENT TRAPPING MEASURES, AND WHEN POSSIBLE, BE LOCATED AWAY FROM STORM DRAIN INLETS, WATERWAYS, AND DRAINAGE CHANNELS.

THE MINIMUM REQUIRED SOIL STABILIZING BMP'S ARE:

C101: PRESERVE NATURAL VEGETATION

C140: DUST CONTROL

C130: SURFACE ROUGHENING

ELEMENT #6 ~ PROTECT SLOPES

CUT AND FILL SLOPES SHALL BE CONSTRUCTED IN A MANNER THAT WILL MINIMIZE EROSION. EXCAVATED MATERIAL SHALL BE PLACED ON THE UPHILL SIDE OF TRENCHES, CONSISTENT WITH SAFETY AND SPACE CONSIDERATIONS. CHECK DAMS SHALL BE PLACED AT REGULAR INTERVALS WITHIN CHANNELS THAT ARE CUT DOWN A SLOPE. SOILS ON SLOPES SHALL BE STABILIZED ACCORDING TO ELEMENT #5 ABOVE. IN ADDITION TO BMPS LISTED IN ELEMENT #5 ABOVE, THE MINIMUM REQUIRED SLOPE PROTECTION

C130: SURFACE ROUGHENING

ELEMENT #7 ~ PROTECT DRAIN INLETS

STORM DRAIN INLETS WILL BE MADE OPERABLE DURING CONSTRUCTION. CLEAN STRUCTURES WHEN SEDIMENT HAS DEPOSITED IN THE STRUCTURE.

ELEMENT #8 ~ STABILIZE CHANNELS AND OUTLETS

OPEN CHANNELS SHALL BE STABILIZED USING ARMORING MATERIAL, ADEQUATE TO PREVENT

EROSION OF OUTLETS, ADJACENT STREAMBANKS, SLOPES, AND DOWNSTREAM REACHES. CHECK DAMS SHALL BE INSTALLED FIFTY FEET ON CENTER IN ALL OPEN DITCHES. THE MINIMUM REQUIRED SLOPE PROTECTION BMP'S ARE:

C207: CHECK DAMS

C209: ROCK LINING OUTLET PROTECTION

ELEMENT #9 ~ CONTROL POLLUTANTS

ALL POLLUTANTS, INCLUDING WASTE MATERIALS AND DEMOLITION DEBRIS, THAT OCCUR ON-SITE DURING CONSTRUCTION SHALL BE HANDLED AND DISPOSED OF IN A MANNER THAT DOES NOT CAUSE CONTAMINATION OF STORMWATER. THE MINIMUM REQUIRED BMP'S ARE:

C152: SAWCUTTING AND SURFACE POLLUTION PREVENTION

ELEMENT #10 ~ CONTROL DE-WATERING

DEWATERING IS NOT ANTICIPATED ON THIS PROJECT.

ELEMENT #11 ~ MAINTAIN BMPS

ALL TEMPORARY AND PERMANENT EROSION AND SEDIMENT CONTROL BMPS SHALL BE INSPECTED WEEKLY, MAINTAINED AND REPAIRED AS REQUIRED TO ASSURE CONTINUED PERFORMANCE. TEMPORARY EROSION AND SEDIMENT BMP'S SHALL BE REMOVED WITHIN 30 DAYS OF FINAL SITE STABILIZATION.

ELEMENT #12 ~ MANAGE THE PROJECT

BMPS SHALL BE INSPECTED, MAINTAINED AND REPAIRED TO ASSURE CONTINUED PERFORMANCE OF THEIR INTENDED FUNCTION. THE SWPPP SHALL BE MAINTAINED AND IMPLEMENTED AS NEEDED.

ELEMENT #13 ~ PROTECT LOW IMPACT DEVELOPMENT BMPS

PROTECT ALL BIORETENTION AND RAIN GARDEN BMPS FROM SEDIMENTATION THROUGH INSTALLATION AND MAINTENANCE OF EROSION AND SEDIMENT CONTROL BMPS ON PORTIONS OF THE SITE THAT DRAIN INTO THE BIORETENTION AND/OR RAIN GARDEN BMPS. RESTORE THE BMPS TO THEIR FULLY FUNCTIONING CONDITION IF THEY ACCUMULATE SEDIMENT EDIMENT DURING CONSTRUCTION. RESTORING THE BMP MUST INCLUDE REMOVAL OF SEDIMENT AND ANY SEDIMENT—LADEN BIORETENTION/RAIN GARDEN SOILS, AND REPLACING THE REMOVED SOILS WITH SOILS MEETING THE DESIGN SPECIFICATION.

PREVENT COMPACTING BIORETENTION AND RAIN GARDEN BMPS BY EXCLUDING CONSTRUCTION EQUIPMENT AND FOOT TRAFFIC. PROTECT COMPLETED LAWN AND LANDSCAPED AREAS FROM COMPACTION DUE TO CONSTRUCTION EQUIPMENT.

CONTROL EROSION AND AVOID INTRODUCING SEDIMENT FROM SURROUNDING LAND USES ONTO PERMEABLE PAVEMENTS. DO NOT ALLOW MUDDY CONSTRUCTION EQUIPMENT ON THE BASE MATERIAL OR PAVEMENT. DO NOT ALLOW SEDIMENT— LADEN RUNOFF ONTO PERMEABLE PAVEMENTS.

PAVEMENTS FOULED WITH SEDIMENTS OR NO LONGER PASSING AN INITIAL INFILTRATION TEST MUST BE CLEANED USING PROCEDURES FROM THE LOCAL STORMWATER MANUAL OR THE MANUFACTURER'S PROCEDURES.

KEEP ALL HEAVY EQUIPMENT OFF EXISTING SOILS UNDER LID FACILITIES THAT HAVE BEEN EXCAVATED TO FINAL GRADE TO RETAIN THE INFILTRATION RATE OF THE SOILS.

FIELD BOOK	DATA	DRAWN BY	CHECKED	SCALE	REV	DATE	REVISION DESCRIPTION	BY	No.	ISSUE DESCRIPTION	DATE	West with
DESIGN:	BASE			HORIZ:			The transit of the tr	- 151	_	PROJECT MEETING	NOV. 14, 2018	KIEWIT INFRASTRUCTURE CO.
STAKING:	DESIGN	PO	DG	VERT:						PRE-APP SUBMITTAL	NOV. 21, 2018	2200 COLUMBIA HOUSE BLVD.
ASBUILT:	XREF:	Al One Omised	20170001000-1	SHEET\2017008_ecP_CND.dwg					3	GRADING PERMIT SUBMITTAL	JAN. 15, 2019	VANCOUVER, WASHINGTON 98661 360.693.1478
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MARBLEMOUNT QUARRY GRADING PERMIT PLANS


SWPPP NOTES

JOB No.2017008 SHEET



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ACIFIC SURVEY SQUALICUM WAY SUITE 111 - BELLINGHAM,



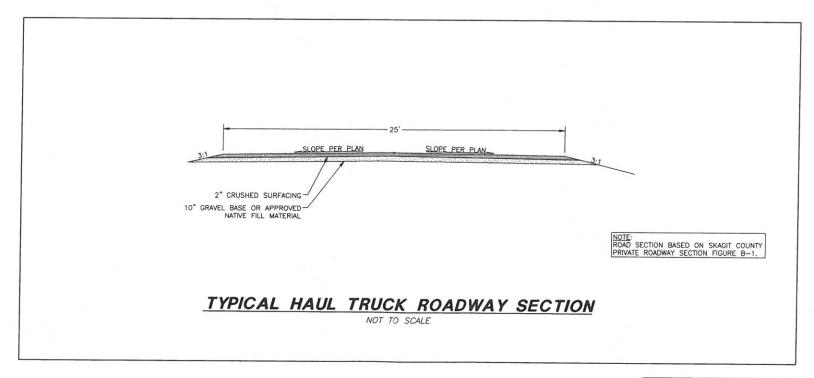

MARBLEMOUNT QUARRY

MARBLEMOUNT, WASHINGTON


GRADING PERMIT PLANS

ROAD DETAILS

JOB No.2017008 SHEET

GENERAL NOTES

- ALL APPROACHES ARE SYMMETRICAL ABOUT CENTERLINE UNLESS OTHER-WISE NOTED.
- 2. WHERE LARGER TRUCK TURNING MOVEMENTS ARE ENCOUNTERED, LARGER RETURN RADII AND RIGHT TURN TAPERS MAY BE REQUIRED BY THE COUNTY ENGINEER.
- 3. WHERE REQUIRED, CULVERTS
 SHALL BE PLACED AT INTERSECTIONS
 TO MAINTAIN DRAINAGE FLOW, ALL
 CULVERTS AND STORMWATER PIPES
 SHALL BE A MINIMUM 12" DIA AND BE
 OF AN APPROVED MATERIAL. COVER
 REQUIREMENTS SHALL MEET WSDOT
 AND MANUFACTURERS SPECS.
- EXCEPT FOR APPROACHES TO EXISTING GRAVEL ROADS, ALL APPROACHES SHALL BE PAVED AS DIRECTED BY THE ENGINEER.
- SEE FIGURE C4 FOR GRADE REQUIREMENTS.

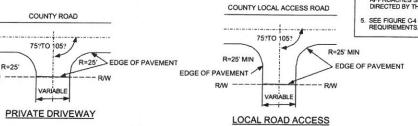



SKAGIT COUNTY DEPARTMENT OF PUBLIC WORKS

EDGE OF PAVEMENT



COUNTY ARTERIAL/COLLECTOR ROAD

ARTERIAL/COLLECTOR ROAD ACCESS


75?TO 105?

R=40'

ROADWAY STANDARDS

COUNTY ROAD ACCESSES

FIGURE C - 3

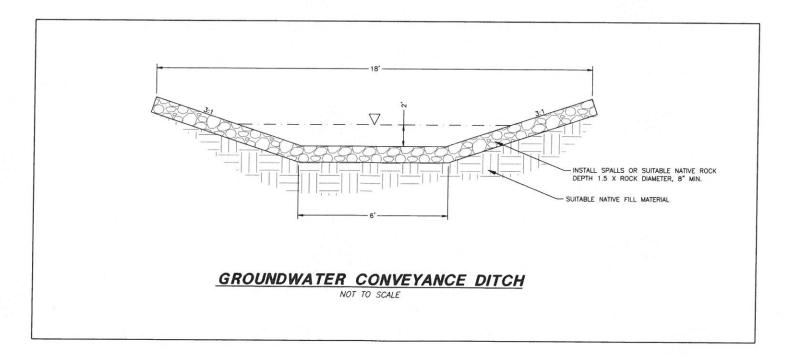

	FIELD BOOK	DATA	DRAWN	CHECKED	SCALE	REV	DATE	REVISION DESCRIPTION	BY	No.	ISSUE DESCRIPTION	DATE	
DESIGN:		BASE			HORIZ:				\neg	1	PROJECT MEETING	NOV. 14, 2018	KIEWIT INFRASTRUCTURE CO.
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ASBUILT:		XREF:									GRADING PERMIT SUBMITTAL	JAN. 15, 2019	VANCOUVER, WASHINGTON 98661
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MARBLEMOUNT QUARRY MARBLEMOUNT , WASHINGTON GRADING PERMIT PLANS

ROAD DETAILS 2

JOB No.2017008 SHEET

INC 4685 www.psesurvey.com FAX:360.671. .7387 H **8 8** 98225 MA RVEY BELLINGHAM,

WAY.S

606

1. No steps are required when height is 4' or less.

2. The bottom of the precast catch basin may be sloped to facilitate cleaning.

The rectangular frame and grate may be installed with the flange up or down. The frame may be cast into the adjustment section.


4. Knockouts shall have a wall thickness of 2° (in) minimum to 2.5° (in) maximum. Provide a 1.5° (in) minimum gap between the knockout wall and the outside of the pipe. After the pipe is installed, fill the gap with joint mortar in accordance with Standard Specification Section 9-04.3.

	CATCH	BASIN DI	MENSIONS	i i
CATCH BASIN DIAMETER	MIN. WALL THICKNESS	MIN. BASE THICKNESS	MAXIMUM KNOCKOUT SIZE	MINIMUM DISTANCE BETWEEN KNOCKOUTS
48"	4"	6"	36"	8"
54"	4.5"	8"	42"	8"
60"	5"	8"	48"	8"
72"	6"	8"	60"	12"
84"	8"	12"	72"	12"
96"	8"	12"	84"	12"
120"	10"	12"	96"	12"
144"	12"	12"	108"	12"

	PIPI	E ALLO	WANCES								
CATCH BASIN DIAMETER	PIPE MATERIAL WITH MAXIMUM INSIDE DIAMETER										
	CONCRETE	ALL METAL	CPSSP ① PP ④	SOLID WALL PVC ②	PROFILE WALL PVC 3						
48"	24"	30"	24"	30"	30"						
54"	30"	36"	30"	36"	36"						
60"	36"	42"	36"	42"	42"						
72"	42"	54"	42"	48"	48"						
84"	54"	60"	54"	48"	48"						
96"	60"	72"	60"	48"	48"						
120"	66"	84"	60"	48"	48"						
144"	78"	96"	60"	48"	48"						


① Corrugated Polyethylene Storm Sewer Pipe (See Standard Specification Section 9-05.20)

(See Standard Specification Section 9-05.12(1))
 (See Standard Specification Section 9-05.12(2))
 Polypropylene Pipe (See Standard Specification Section 9-05.24)

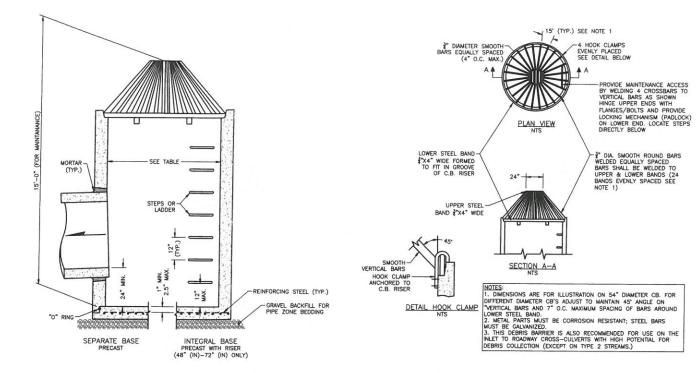

OPEN TOP BIRDCAGE CATCH BASIN DETAIL

NOT TO SCALE

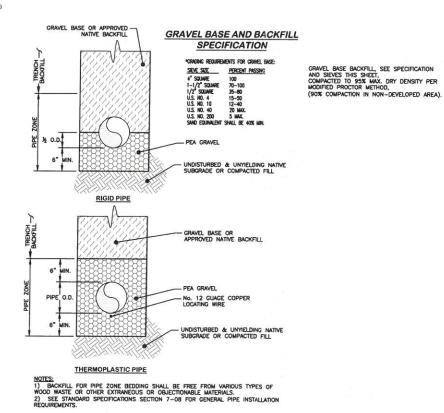

PIPE ZONE BEDDING AND BACKFILL SPECIFICATIONS NOT TO SCALE

BY No. ISSUE DESCRIPTION DATE KIEWIT INFRASTRUCTURE CO. 1 PROJECT MEETING NOV. 14, 2018 2 PRE-APP SUBMITTAL



MARBLEMOUNT QUARRY MARBLEMOUNT , WASHINGTON GRADING PERMIT PLANS


STORM DETAILS


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SQUALICUM W FIELD BOOK SURVEY REFERENCE


SCALE REV DATE REVISION DESCRIPTION HORIZ: DESIGN 2200 COLUMBIA HOUSE BLVD. VANCOUVER, WASHINGTON 98661 MOV. 21, 2018 JAN. 15, 2019 360.693.1478 DWG: P:\Pse Project\2017008\DWGs_SHEET\2017008_ecP_CND.dw PLAN CHECK REVISIONS APPLICANT





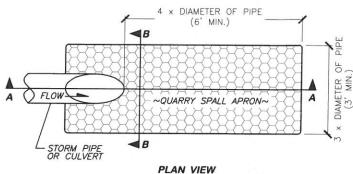

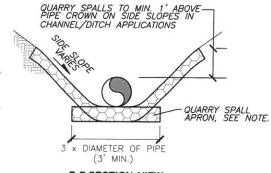B-B SECTION VIEW

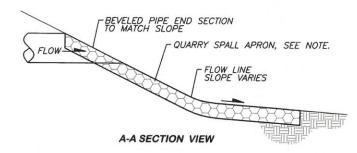

OUTLET PROTECTION NOTE: THE RECEIVING CHANNEL OR SLOPE AT THE OUTLET OF A STORMWATER PIPE OR CULVERT SHALL BE PROTECTED FROM EROSION BY OR CULVERT SHALL BE PROTECTED FROM EROSION BY QUARRY SPALL APRON A MINIMUM OF 6 FEET DOWNSTREAM AND EXTENDING UP THE CHANNEL SIDES A MINIMUM OF 1-FOOT ABOVE THE CROWN. FOR PIPES LARGER THAN 18 INCHES IN DIAMETER, THE OUTLET PROTECTION LINING OF THE CHANNEL IS LENGTHENED TO FOUR TIMES THE DIAMETER OF THE CULVERT. INSTALL QUARRY SPALL APRONS PER STD. SPEC. 8-15.3(6) & 9-13.6 OR SUITABLE NATIVE MATERIAL.

OUTLET PROTECTION DETAIL

NOT TO SCALE

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MARBLEMOUNT QUARRY MARBLEMOUNT, WASHINGTON
GRADING PERMIT PLANS

STORM DETAILS 2

JOB No. 2017008 SHEET